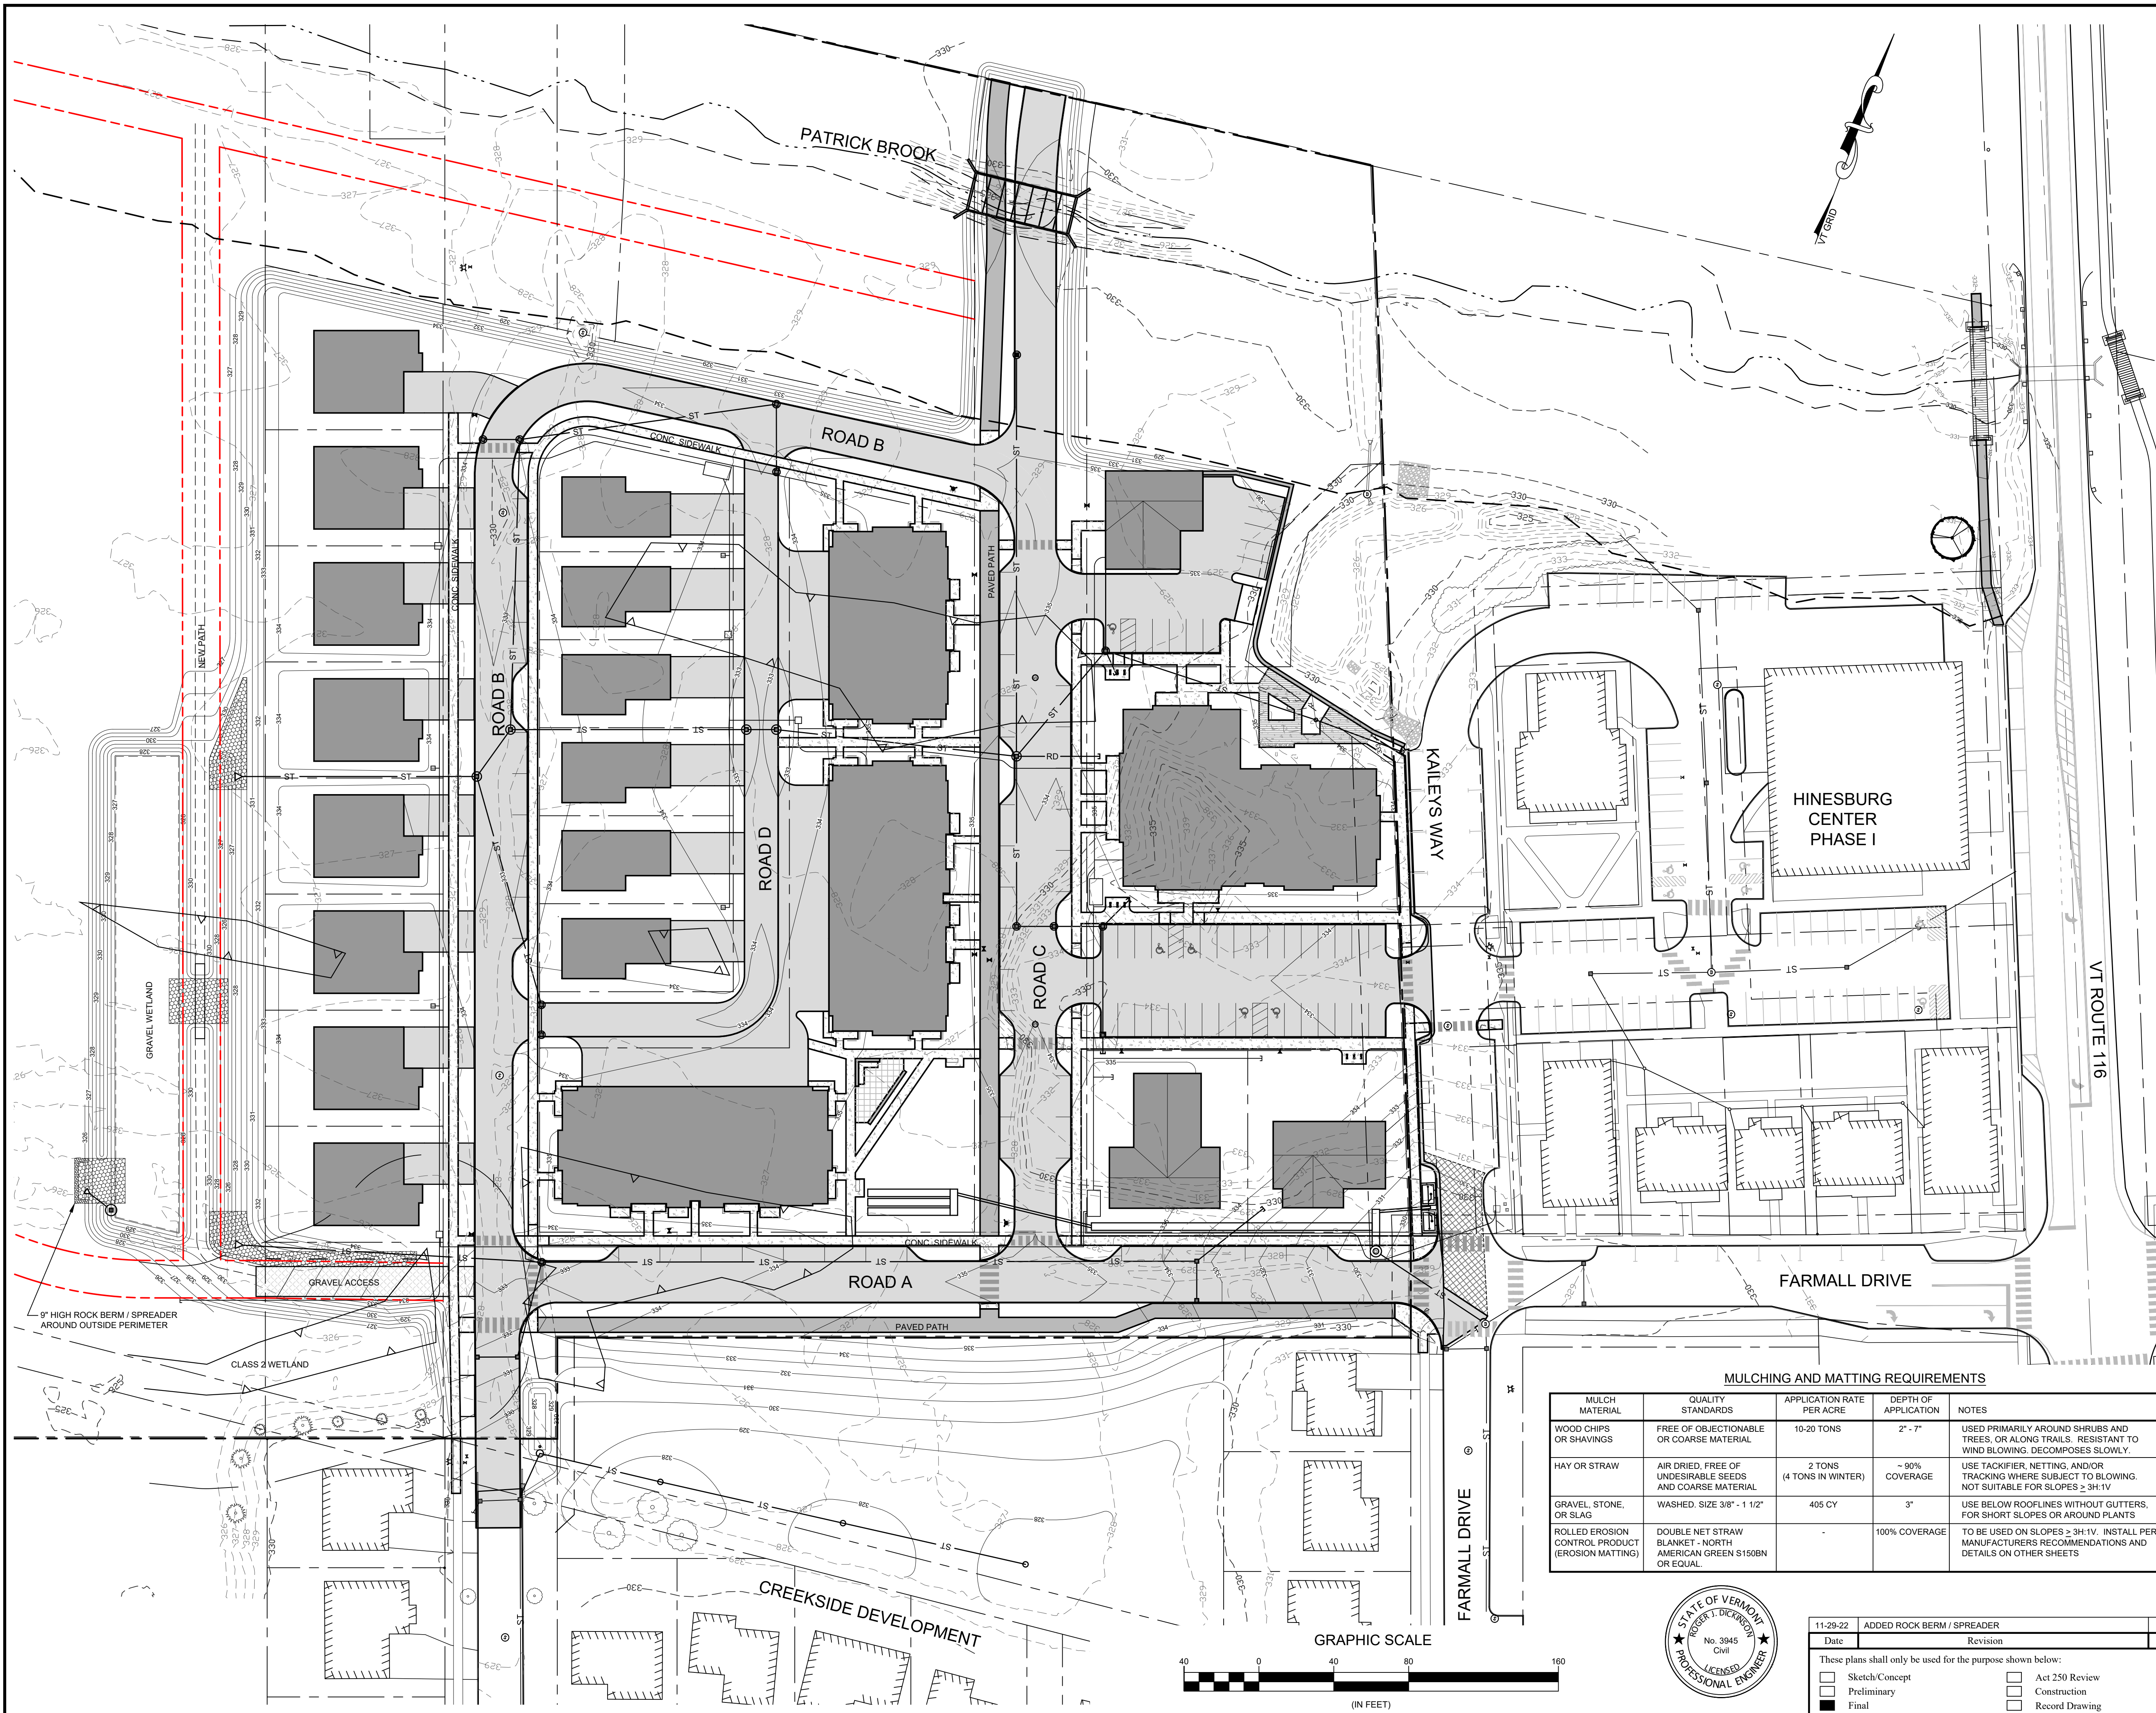


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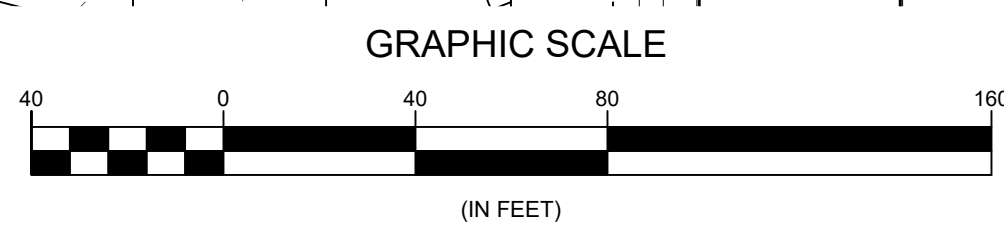


LEGEND

	BUILDING ROOFTOP
	NEW PAVED STREETS & DRIVES
	NEW PAVED/CONCRETE WALKS
	STONE RIP-RAP

MULCHING AND MATTING REQUIREMENTS

MULCH MATERIAL	QUALITY STANDARDS	APPLICATION RATE PER ACRE	DEPTH OF APPLICATION	NOTES
WOOD CHIPS OR SHAVINGS	FREE OF OBJECTIONABLE OR COARSE MATERIAL	10-20 TONS	2' - 7"	USED PRIMARILY AROUND SHRUBS AND TREES, OR ALONG TRAILS. RESISTANT TO WIND BLOWING. DECOMPOSES SLOWLY.
HAY OR STRAW	AIR DRIED, FREE OF UNDESIRABLE SEEDS AND COARSE MATERIAL	2 TONS (4 TONS IN WINTER)	~ 90% COVERAGE	USE TACKIFIER, NETTING, AND/OR TRACKING WHERE SUBJECT TO BLOWING. NOT SUITABLE FOR SLOPES ≥ 3H:1V
GRAVEL, STONE, OR SLAG	WASHED, SIZE 3/8" - 1 1/2"	405 CY	3"	USE BELOW ROOFLINES WITHOUT GUTTERS FOR SHORT SLOPES OR AROUND PLANTS
ROLLED EROSION CONTROL PRODUCT (EROSION MATTING)	DOUBLE NET STRAW BLANKET - NORTH AMERICAN GREEN S150BN OR EQUAL		100% COVERAGE	TO BE USED ON SLOPES ≥ 3H:1V. INSTALL PER MANUFACTURER'S RECOMMENDATIONS AND DETAILS ON OTHER SHEETS



11-29-22	ADDED ROCK BERM / SPREADER	RD
Date	Revision	By
These plans shall only be used for the purpose shown below:		
<input type="checkbox"/> Sketch/Concept	<input type="checkbox"/> Act 250 Review	
<input type="checkbox"/> Preliminary	<input type="checkbox"/> Construction	
<input type="checkbox"/> Final	<input type="checkbox"/> Record Drawing	

LANDS OF HINESBURG CENTER, LLC
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EROSION PREVENTION AND SEDIMENT CONTROL STABILIZATION PLAN

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Project No. 19054
 Survey N/A
 Design NDS/RD
 Drawn DLH
 Checked RJD
 Date 5/11/22
 Scale AS NOTED
 Sheet number 9C